



PLOTTED: 9/10/2013 10:54 AM
 SAVD: 9/30/2013 2:14 PM Trade L. Zerr
 G:\Projects\159\159-P5-001 Well Installations 10-2012\Civil-Dwg\As-Recorded\Well Site Plan.dwg

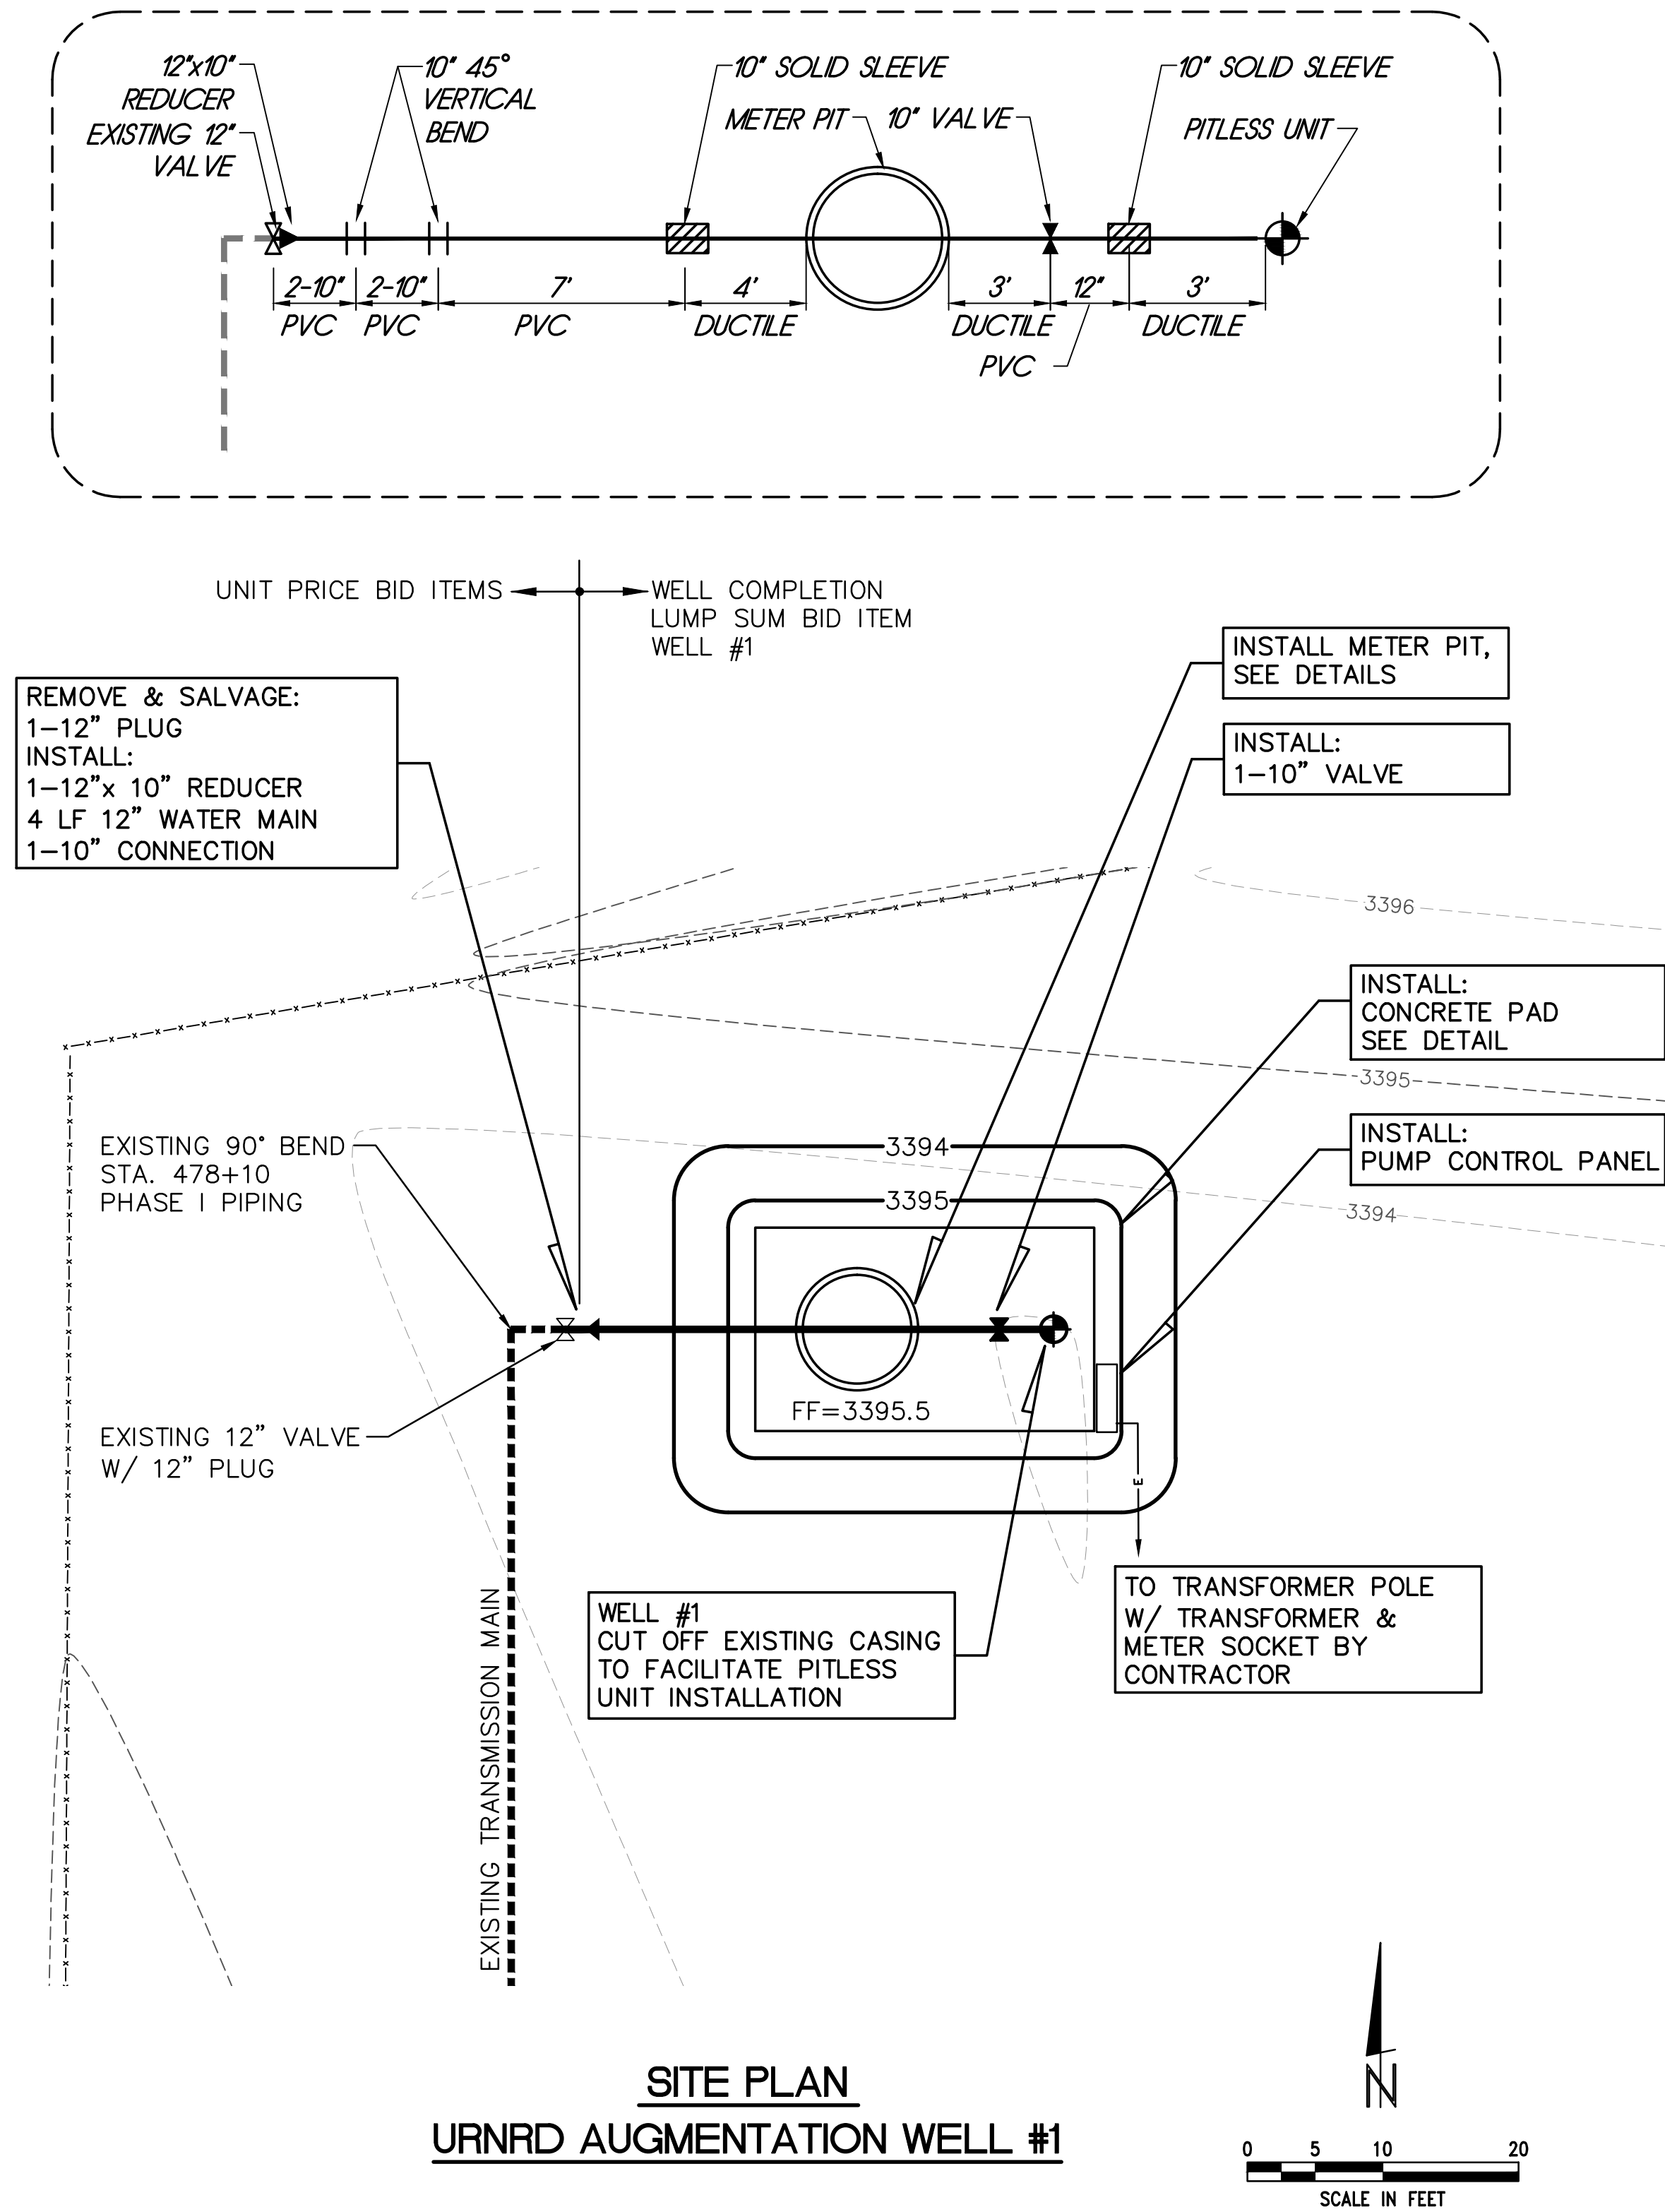

- NOTES:
- ALL 10" WATER MAIN THROUGH METER PIT SHALL BE CLASS 350 DUCTILE.
 - CONTRACTOR TO COORDINATE W/ SWPPD FOR POWER POLE LOCATION/REQUIRED DISCONNECT AND ALL UNDERGROUND FROM POWER POLE TO PANEL BOXES. POWER POLE TO BE MIN. 50' AWAY BUT NO GREATER THAN 75'.
 - CONDUIT RUNS NOT SHOWN.
 - CONTRACTOR VERIFY CONNECTION POINT BURY DEPTH PRIOR TO INSTALLING PITLESS UNIT.
 - PIPING SHALL BE LAID TO ALLOW FOR AIR RELEASE TO EXISTING TRANSMISSION MAIN OR AIR RELEASE IN METER PIT.

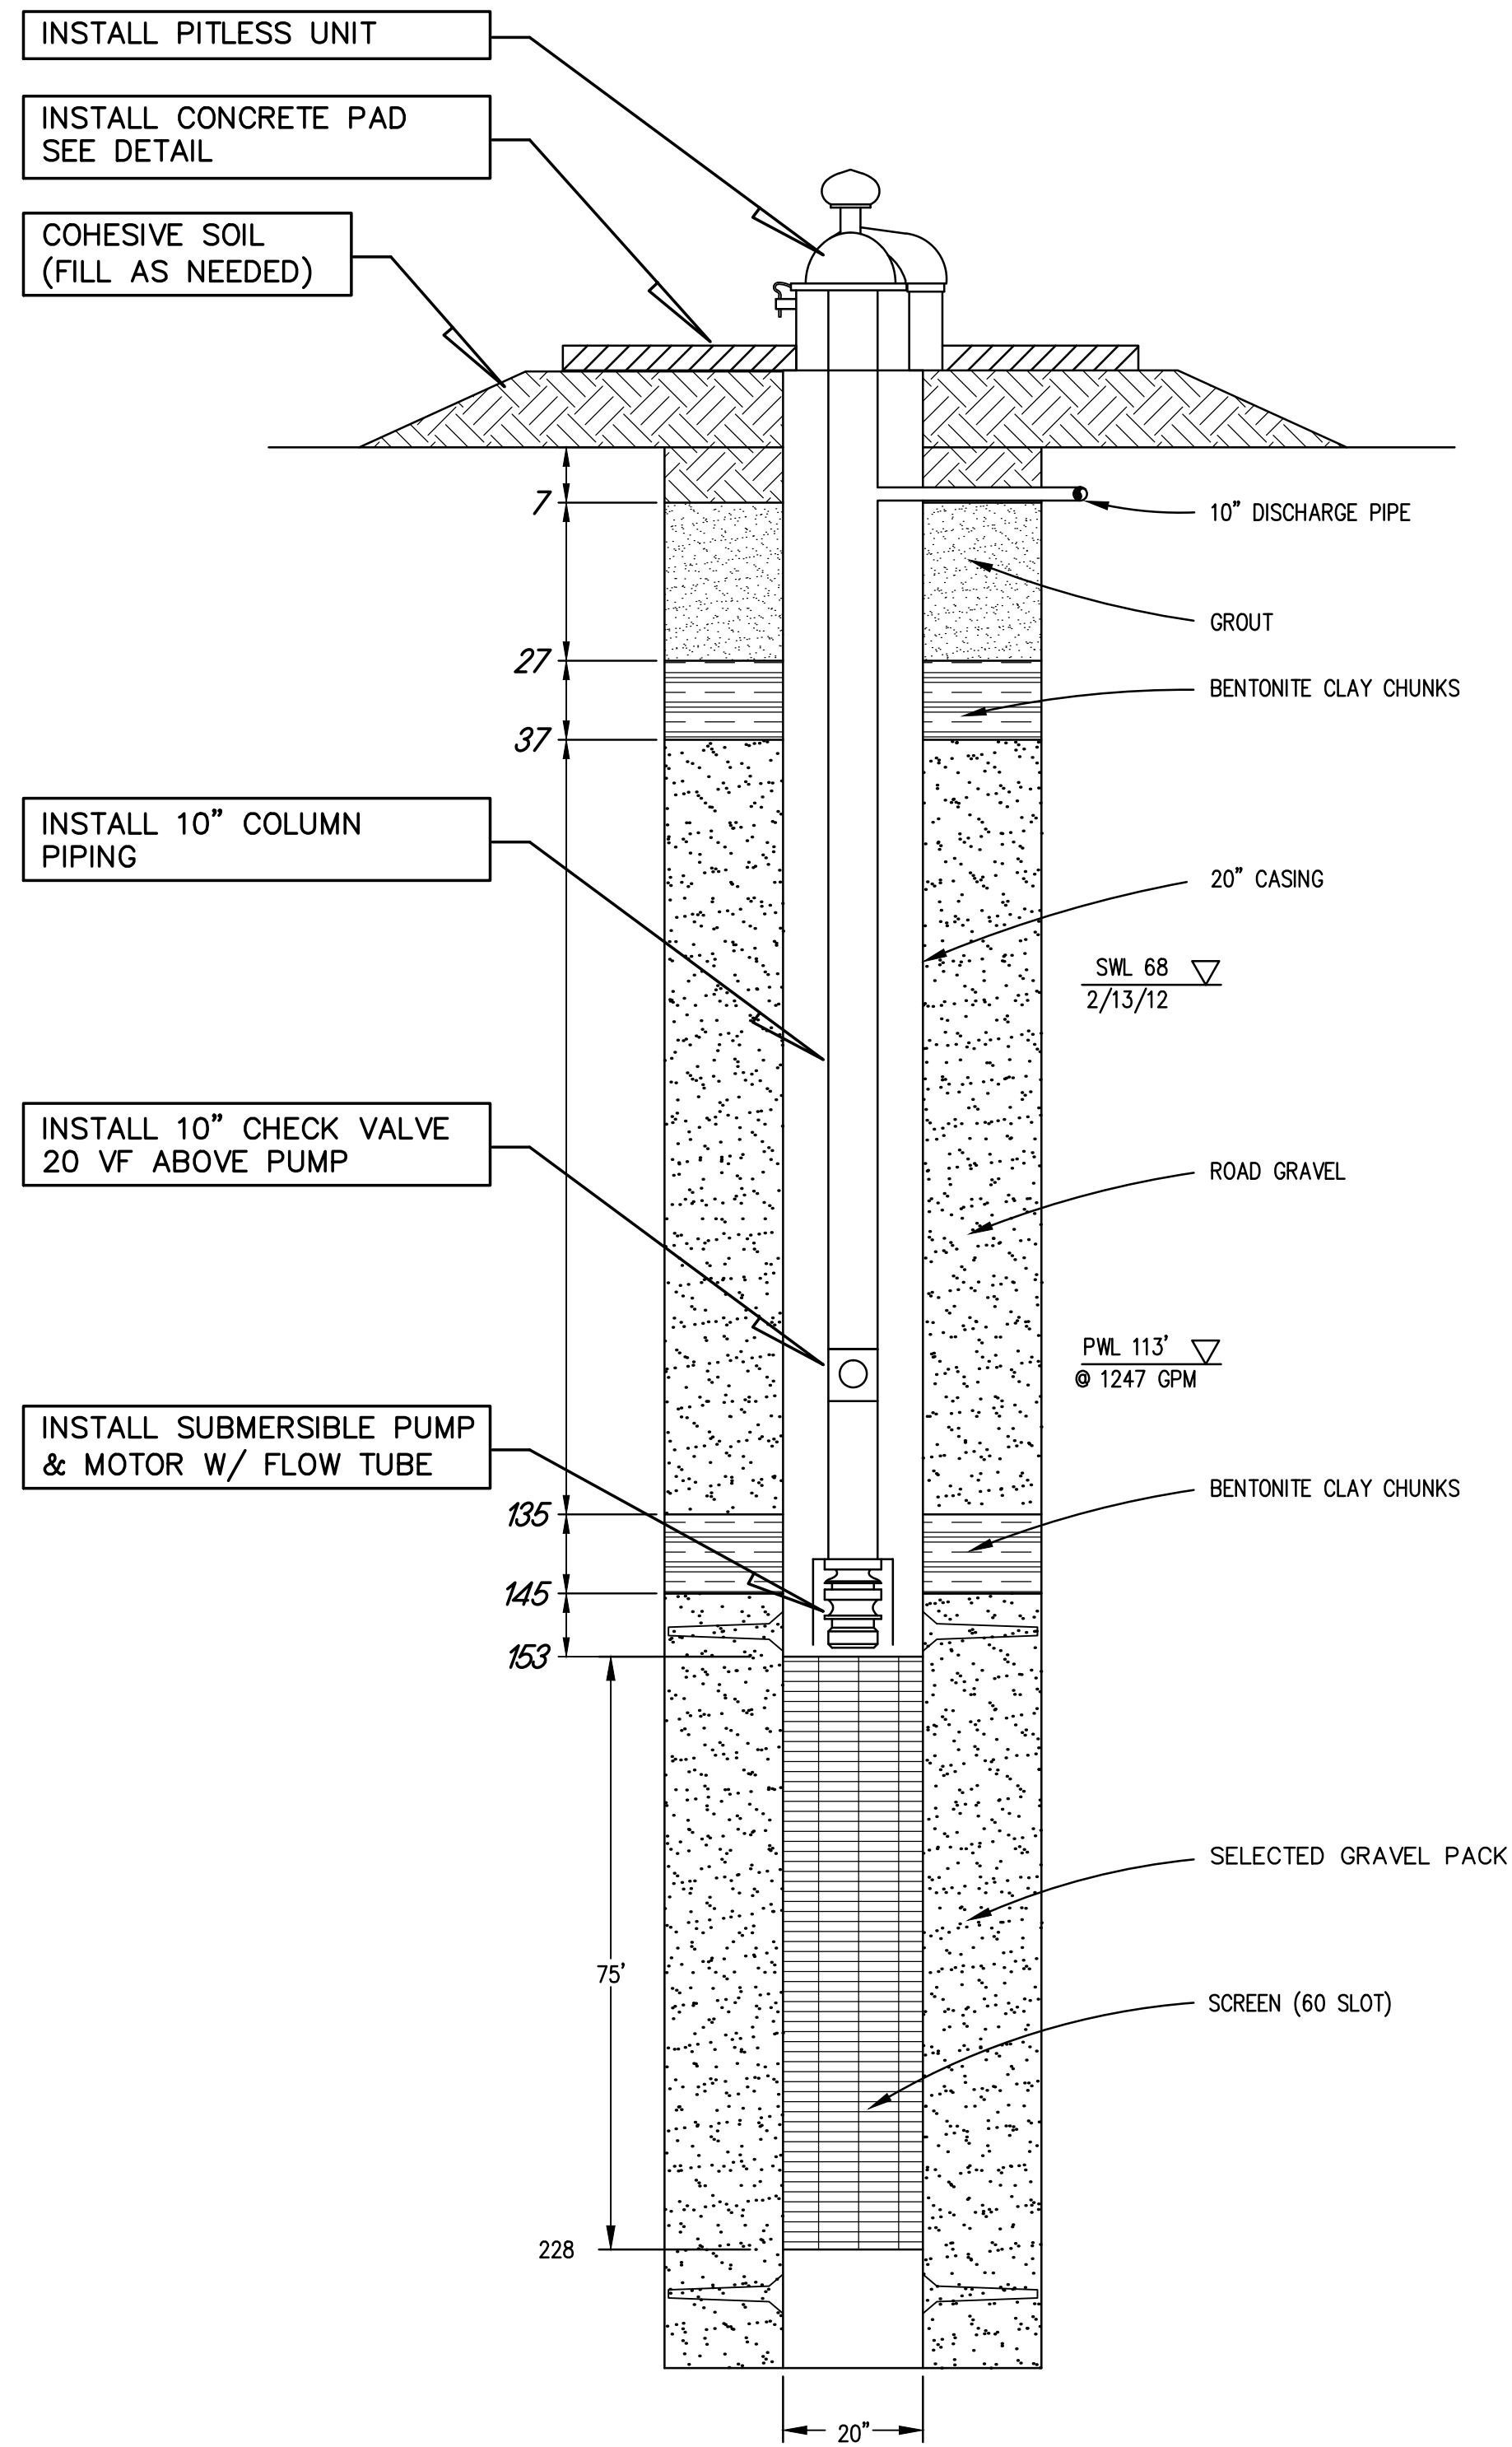

TEST PUMP DATA - WELL #1		
	START WATER LEVEL	END WATER LEVEL
AUG. WELL #1	57.857	113.107
OLD #1	66.816	67.977
AUG. WELL #2	71.951	72.249

SPECIFIC CAPACITY
25.3

FINAL HP	125
PUMP BOWLS	11CLC
TRIM	6.875
STAGE	2

REVISIONS
 BY

Miller & Associates
 Consulting Engineers, P.C.
 Kearney, NE (308) 234-6456
 McCook, NE (308) 345-3710

URNRD - AUGMENTATION - WATER SUPPLY WELLS & PIPING
 URNRD AUGMENTATION WELL #1
 DUNDY COUNTY, NEBRASKA

"AS RECORDED"
 FROM INFORMATION PROVIDED BY THE CONTRACTOR.
 DATE: 07-2013 BY: TLZ
 THIS DOCUMENT WAS ORIGINALLY ISSUED AND SEALED BY CHRIS A. MILLER (E-8775), ON 12/10/2012.
 THIS MEDIA SHOULD NOT BE CONSIDERED A CERTIFIED DOCUMENT.

VERIFY SCALES
 BAR IS ONE INCH ON ORIGINAL DRAWING
 0 1"
 IF NOT ONE INCH ON THIS SHEET, ADJUST SCALES ACCORDINGLY.

SCALE: AS SHOWN
 PROJECT NO. 159-P5-001
 DATE: DECEMBER, 2012
 FIELD BOOK M&A DWG NO. 25318
 DRAWN BY: BSF APRVD BY:
 SHEET 2