



PLOTTED: 10/21/2013 10:22 AM
 SAVED: 10/21/2013 10:21 AM
 C:\Projects\159-P5-001\Well Installations 10-2012\Civil-Dwg\As-Recorded\Well Site Plan.dwg

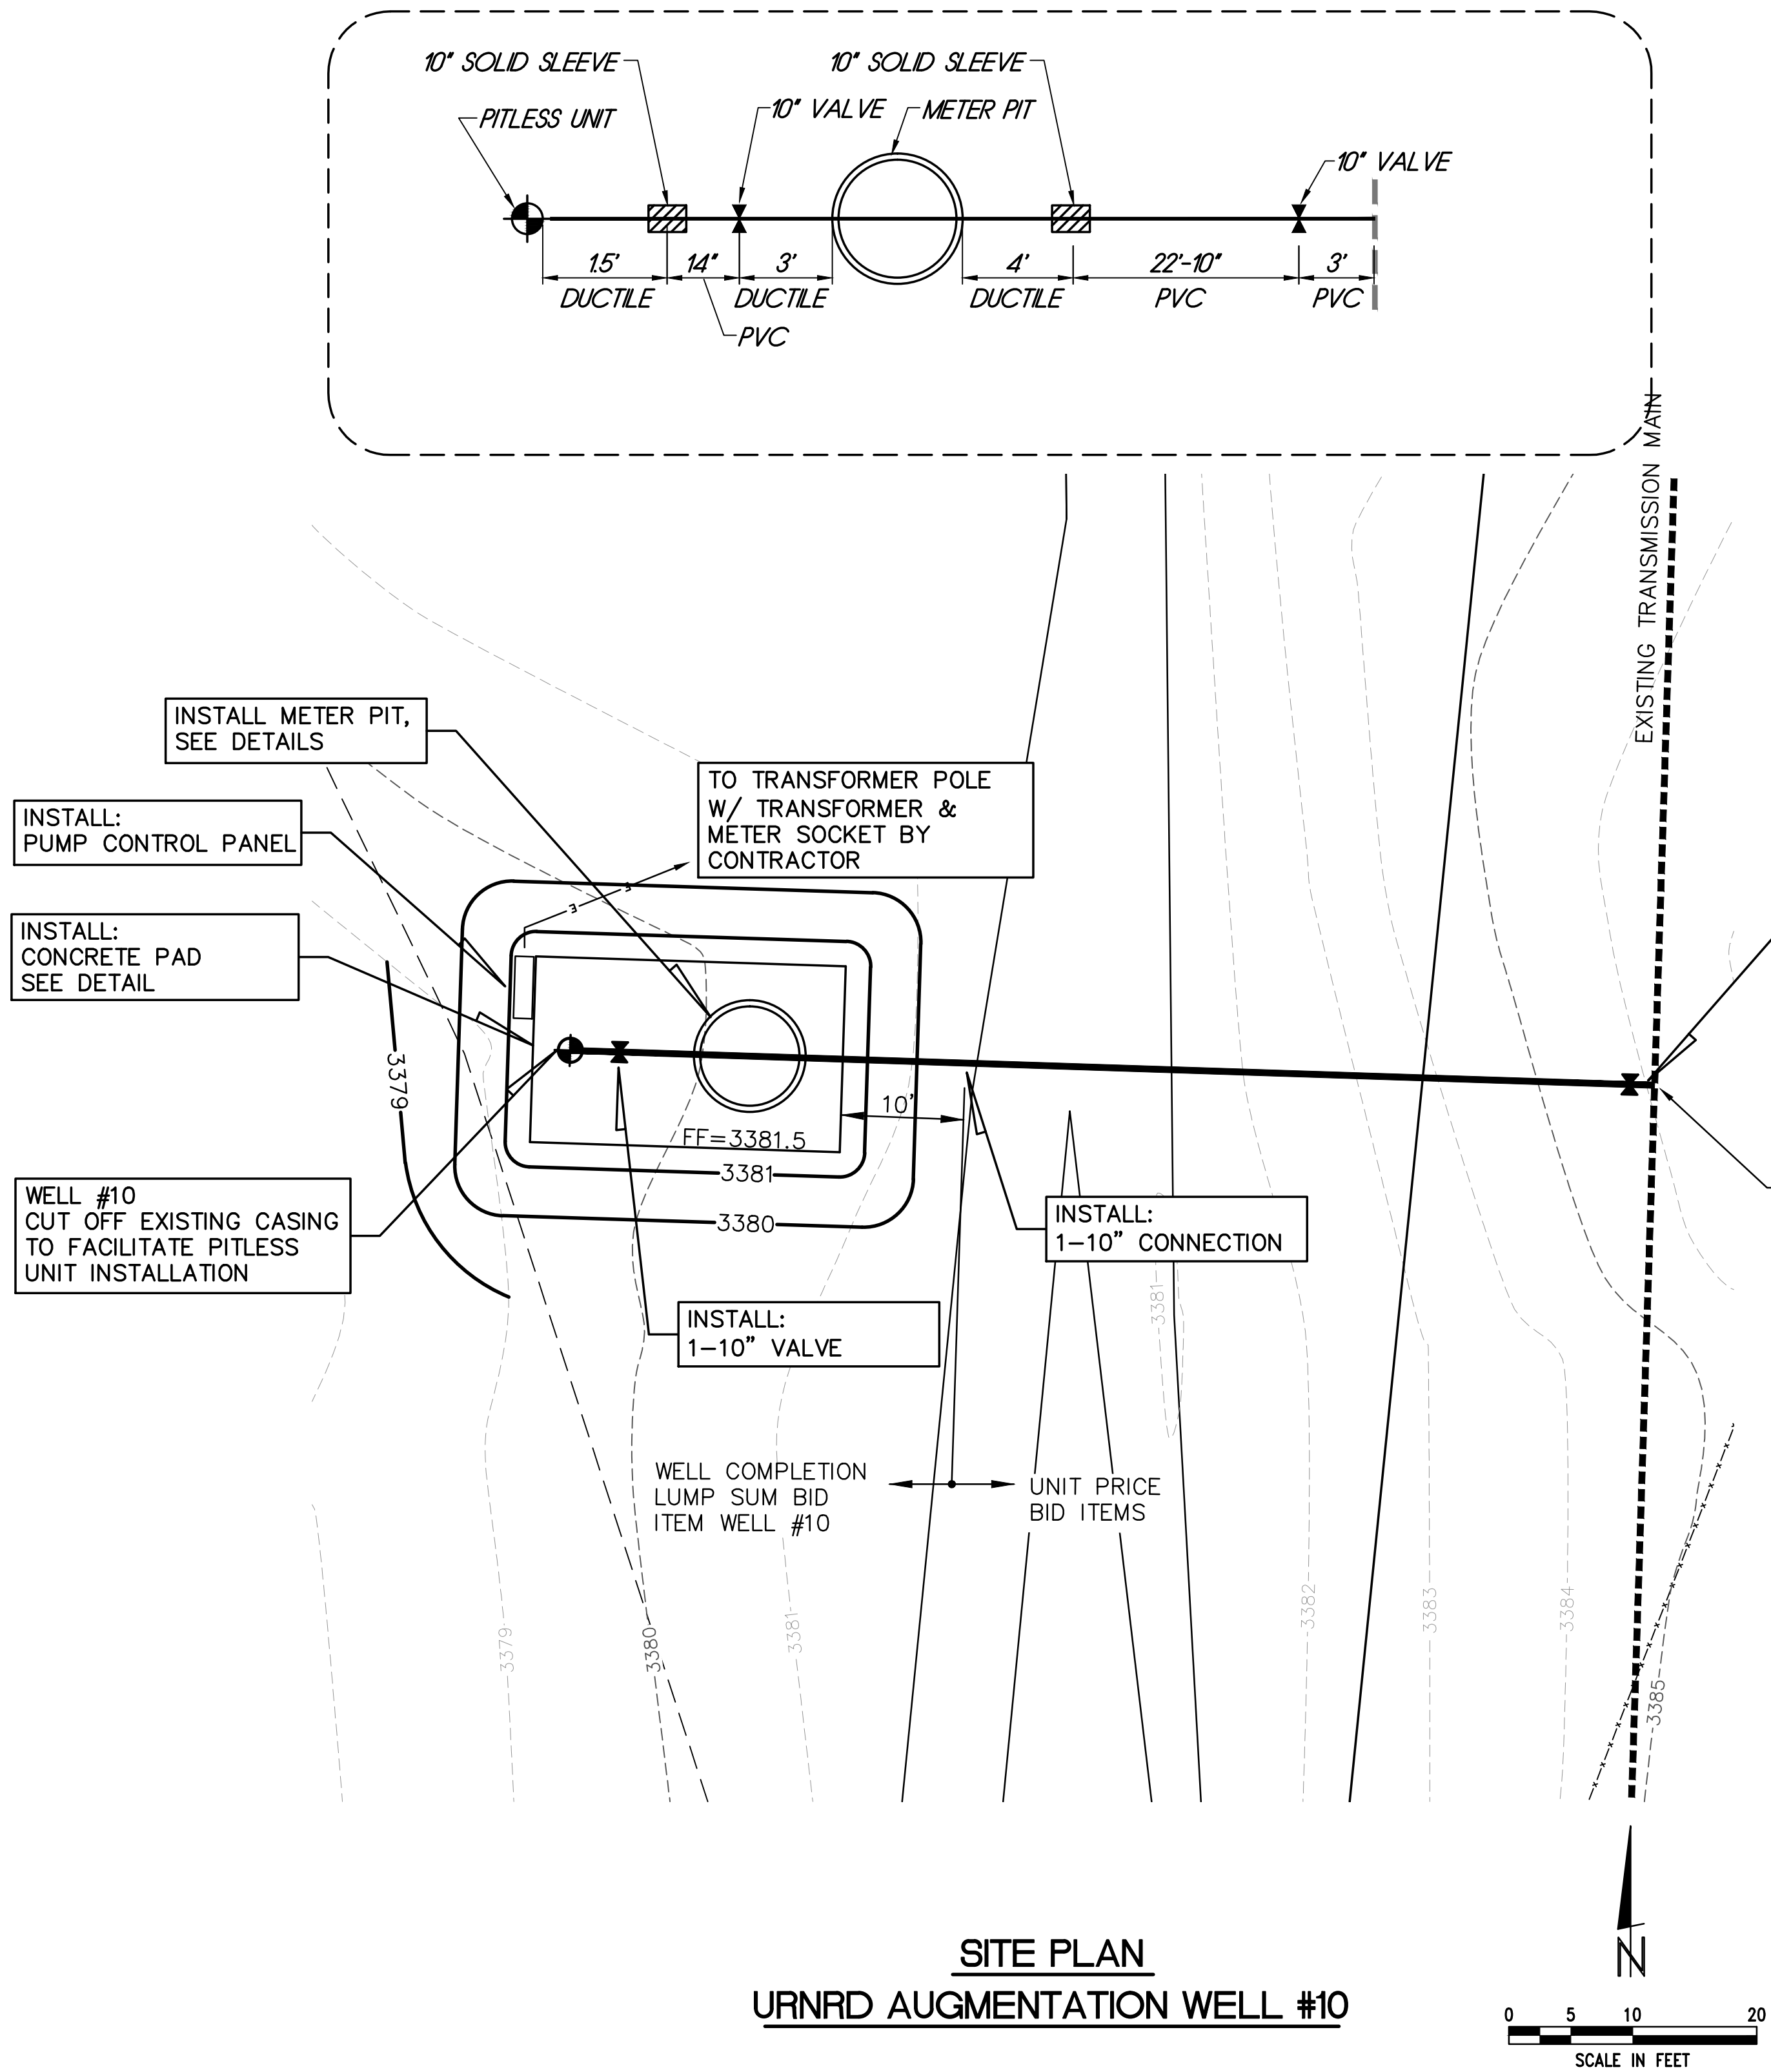

SITE PLAN
 URNRD AUGMENTATION WELL #10

- NOTES:
- ALL 10" WATER MAIN THROUGH METER PIT SHALL BE CLASS 350 DUCTILE.
 - CONTRACTOR TO COORDINATE W/ SWPPD FOR POWER POLE LOCATION/REQUIRED DISCONNECT AND ALL UNDERGROUND FROM POWER POLE TO PANEL BOXES. POWER POLE TO BE MIN. 50' AWAY BUT NO GREATER THAN 75'.
 - CONDUIT RUNS NOT SHOWN.
 - CONTRACTOR VERIFY CONNECTION POINT BURY DEPTH PRIOR TO INSTALLING PITLESS UNIT.
 - PIPING SHALL BE LAID TO ALLOW FOR AIR RELEASE TO EXISTING TRANSMISSION MAIN OR AIR RELEASE IN METER PIT.

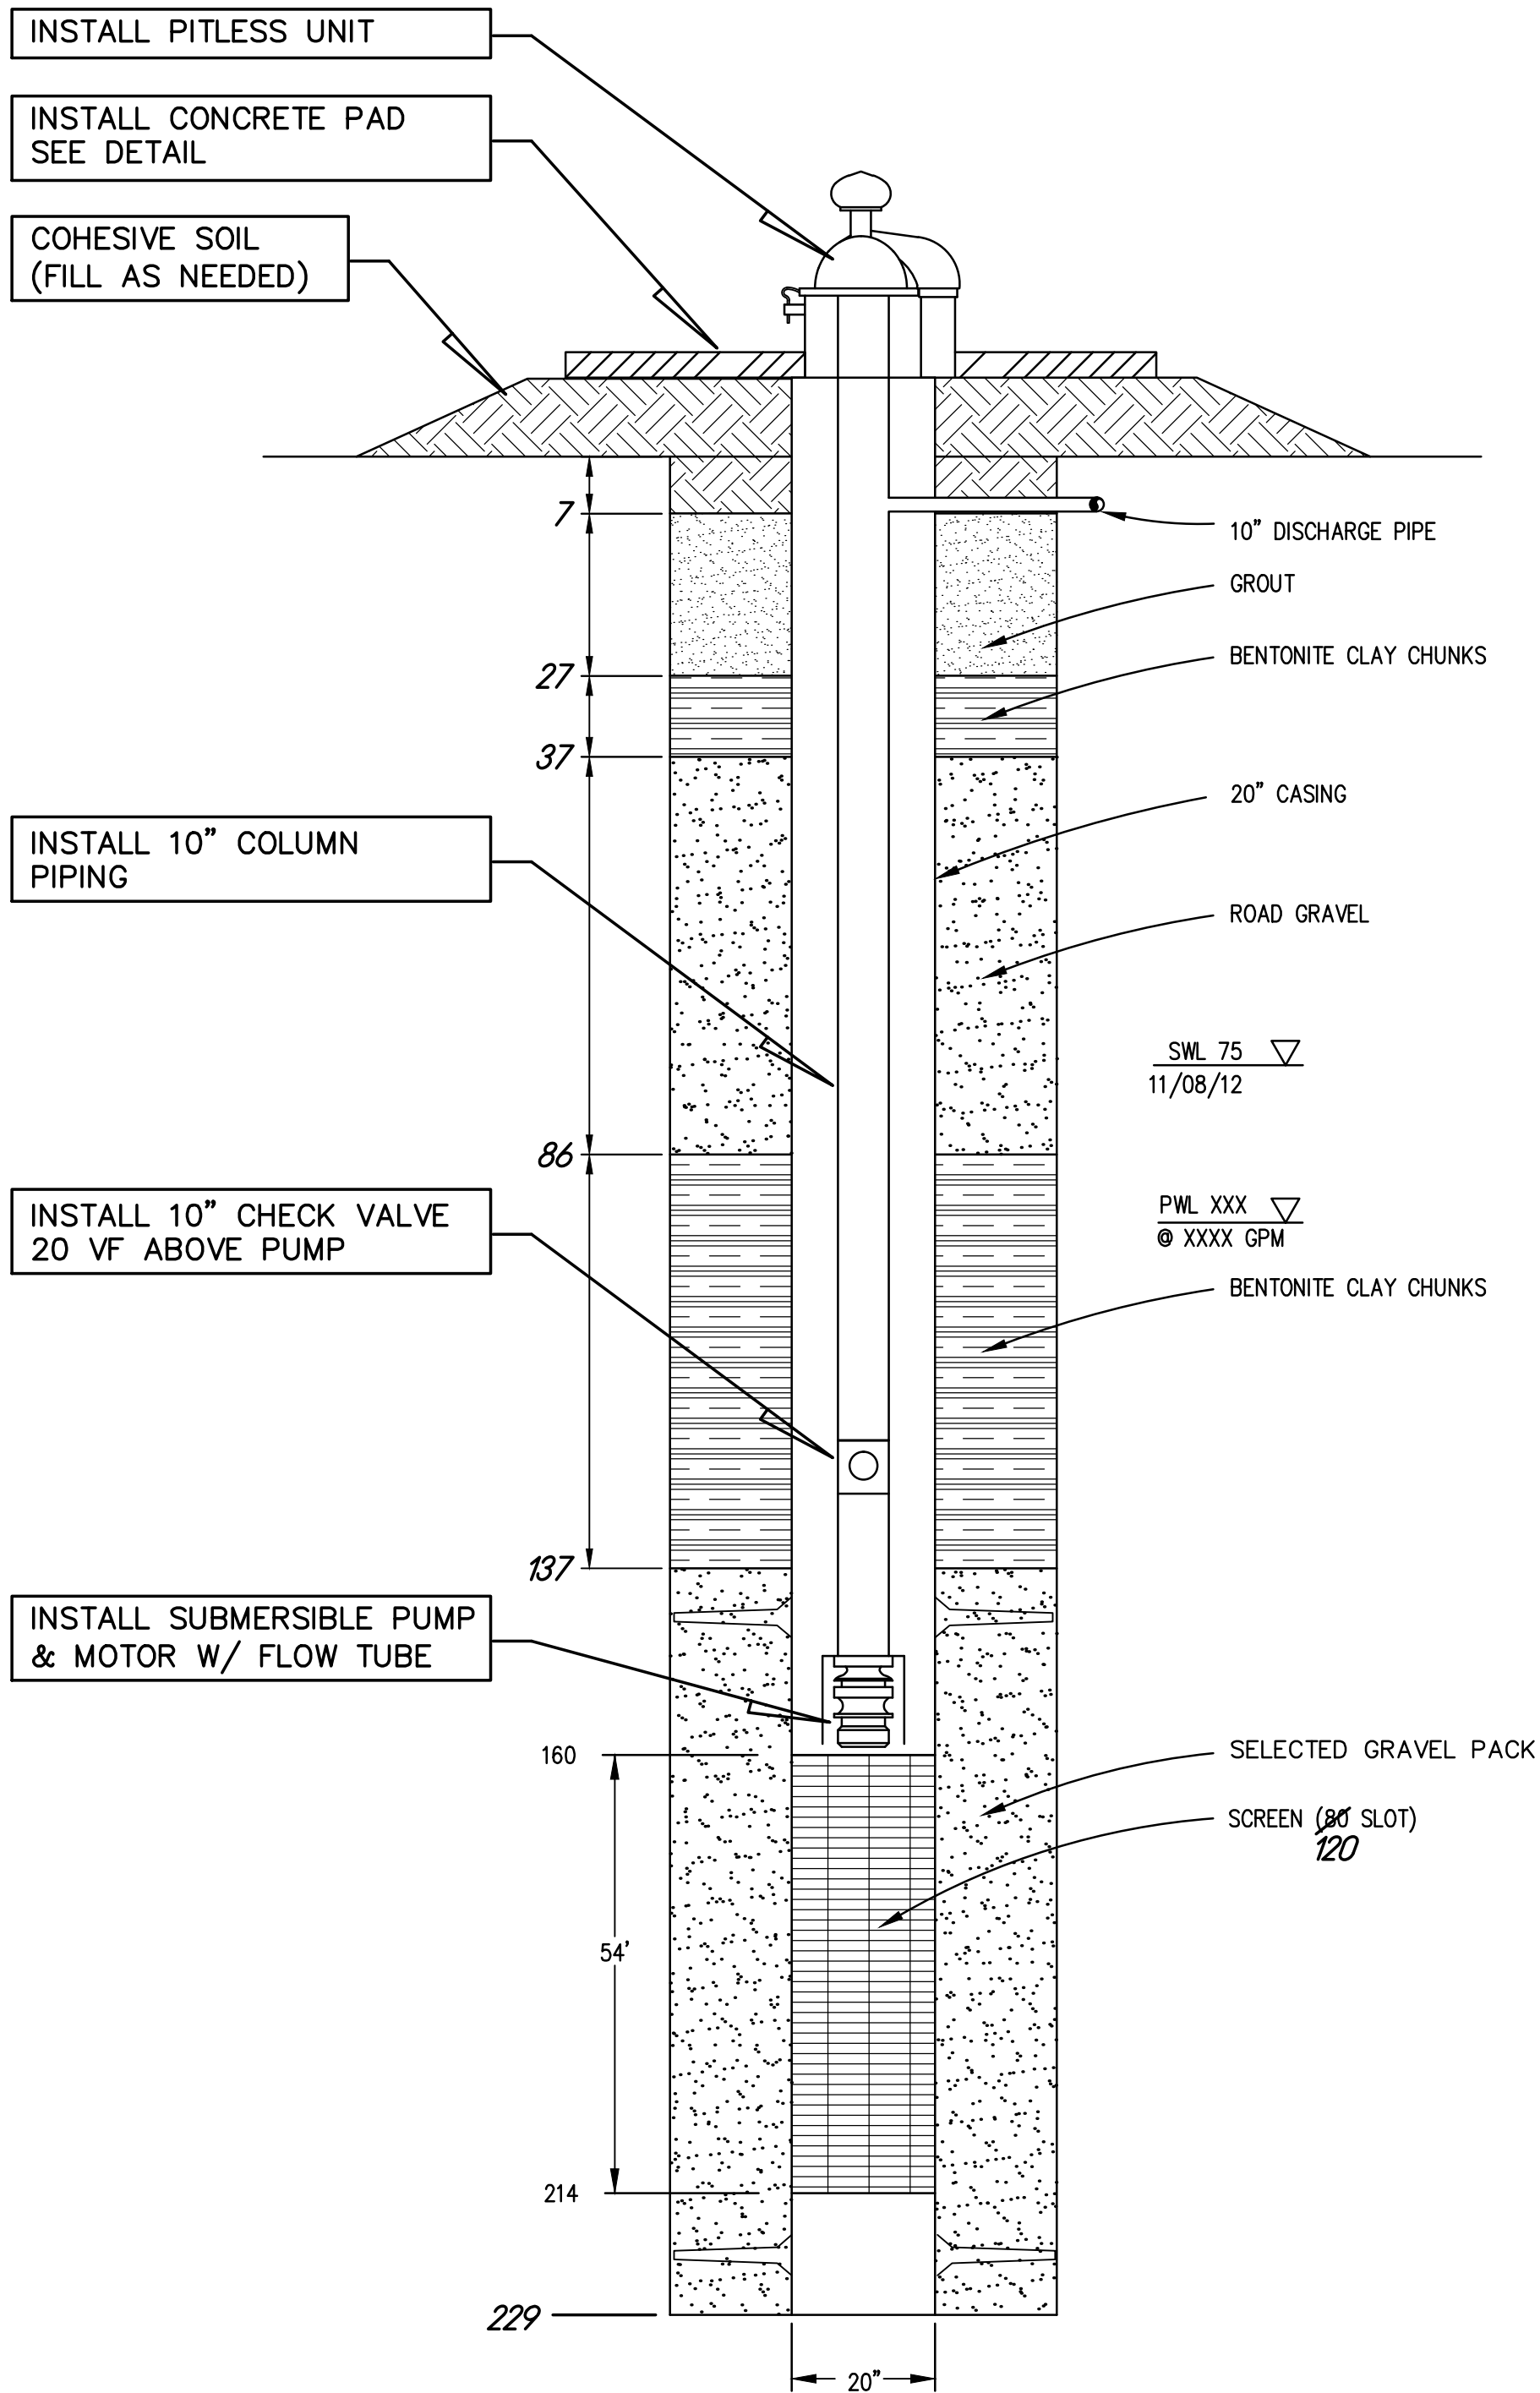

TEST PUMP DATA - WELL #10		
	START WATER LEVEL	END WATER LEVEL
AUG. WELL #10	67.96	95.473
AUG. WELL #8	70.977	71.795
OLD IRRIGATION WELL #10	57.8	60.275

SPECIFIC
 CAPACITY
 50.9

FINAL HP	100
PUMP BOWLS	11CLC
TRIM	7.5625
STAGE	1

URNRD AUGMENTATION WELL #10
 CONSTRUCTION

REVISIONS	BY

Miller & Associates
 Consulting Engineers, P.C.
 Kearney, NE (308) 234-6456
 McCook, NE (308) 345-3710

URNRD - AUGMENTATION - WATER SUPPLY WELLS & PIPING
 URNRD AUGMENTATION WELL #10
 DUNDY COUNTY, NEBRASKA

"AS RECORDED"
 FROM INFORMATION PROVIDED
 BY THE CONTRACTOR.
 DATE: 07-2013 BY: TLZ
 THIS DOCUMENT WAS ORIGINALLY
 ISSUED AND SEALED BY
 CHRIS A. MILLER
 (E-8775), ON
 12/10/2012.
 THIS MEDIA SHOULD NOT
 BE CONSIDERED A
 CERTIFIED DOCUMENT.

VERIFY SCALES
 BAR IS ONE INCH ON
 ORIGINAL DRAWING
 0 1"
 IF NOT ONE INCH ON THIS
 SHEET, ADJUST SCALES
 ACCORDINGLY.

SCALE: AS SHOWN
 PROJECT NO. 159-P5-001
 DATE: DECEMBER, 2012
 FIELD BOOK M&A DWG NO. 25300
 DRAWN BY: BSF APRVD BY:
 SHEET 20