



PLOTTED: 9/10/2013 11:00 AM
 SAVED: 9/30/2013 2:14 PM Travis L. Zerr
 C:\Projects\159\159-P5-001\Well Installations 10-2012\Civil-Dwg\As-Recorded\Well Site Plan.dwg

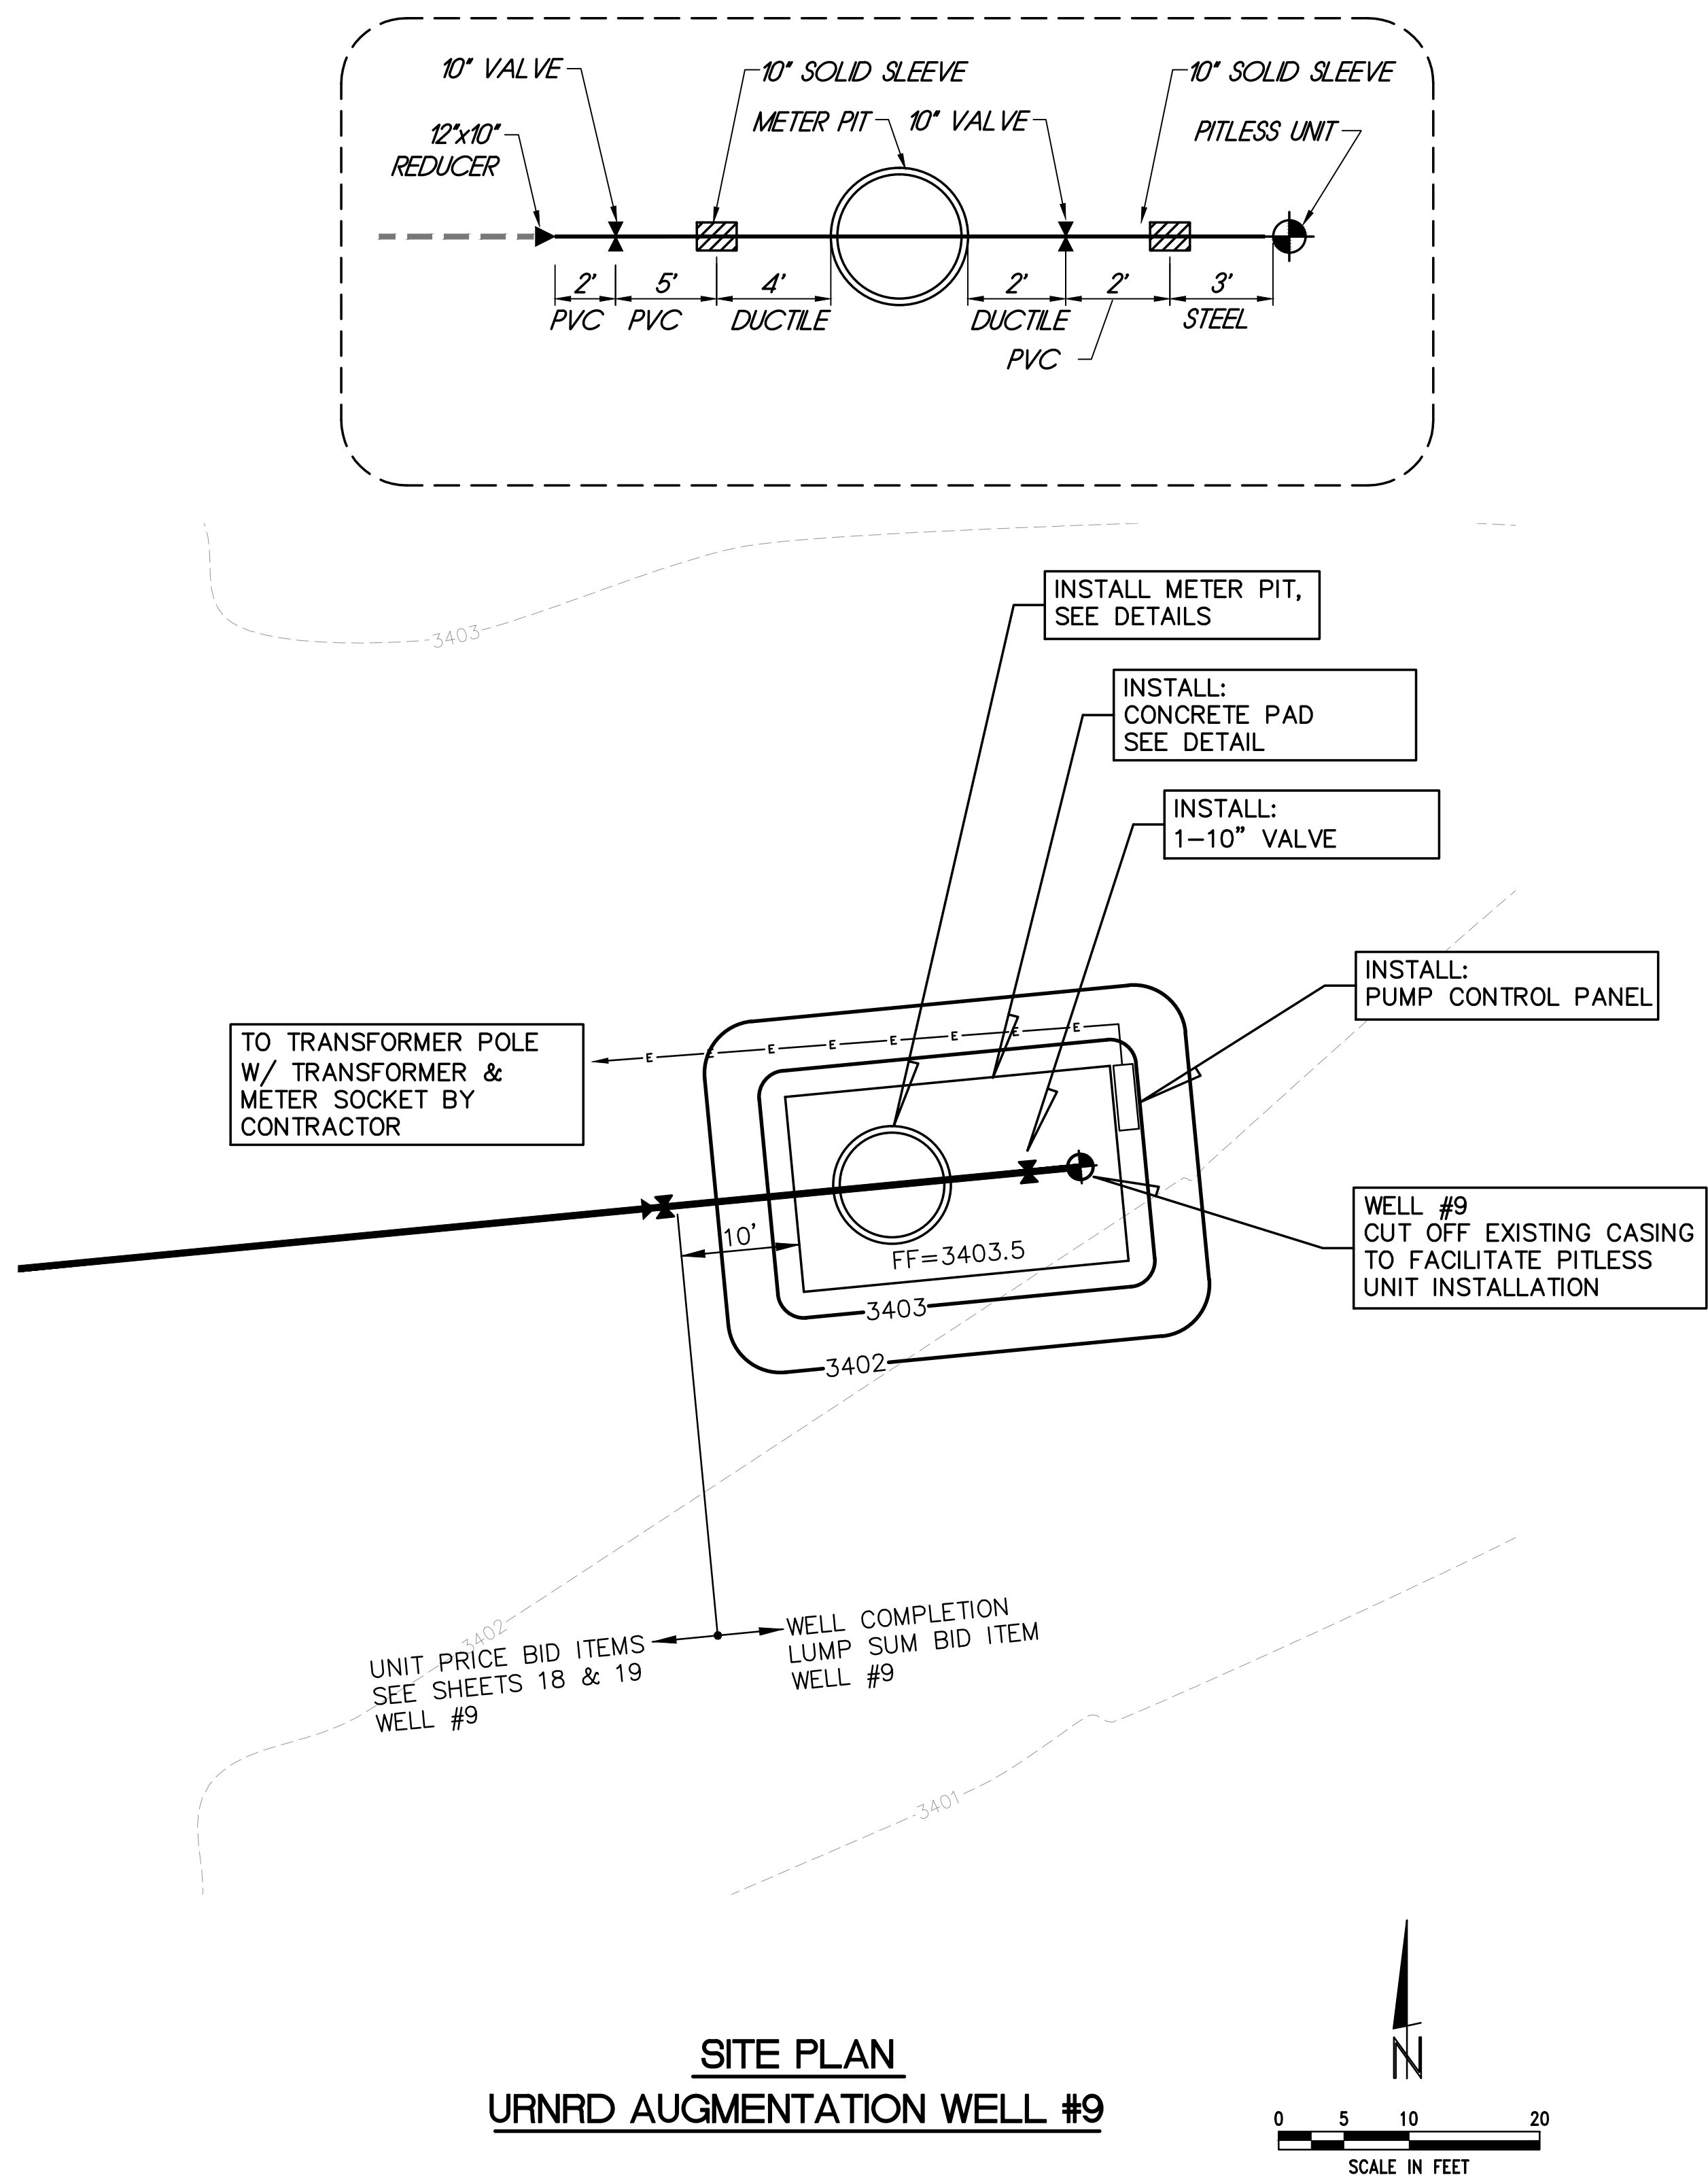

- NOTES:
- ALL 10" WATER MAIN THROUGH METER PIT SHALL BE CLASS 350 DUCTILE.
 - CONTRACTOR TO COORDINATE W/ SWPPD FOR POWER POLE LOCATION/REQUIRED DISCONNECT AND ALL UNDERGROUND FROM POWER POLE TO PANEL BOXES. POWER POLE TO BE MIN. 50' AWAY BUT NO GREATER THAN 75'.
 - CONDUIT RUNS NOT SHOWN.
 - CONTRACTOR VERIFY CONNECTION POINT BURY DEPTH PRIOR TO INSTALLING PITLESS UNIT.
 - PIPING SHALL BE LAID TO ALLOW FOR AIR RELEASE TO EXISTING TRANSMISSION MAIN OR AIR RELEASE IN METER PIT.

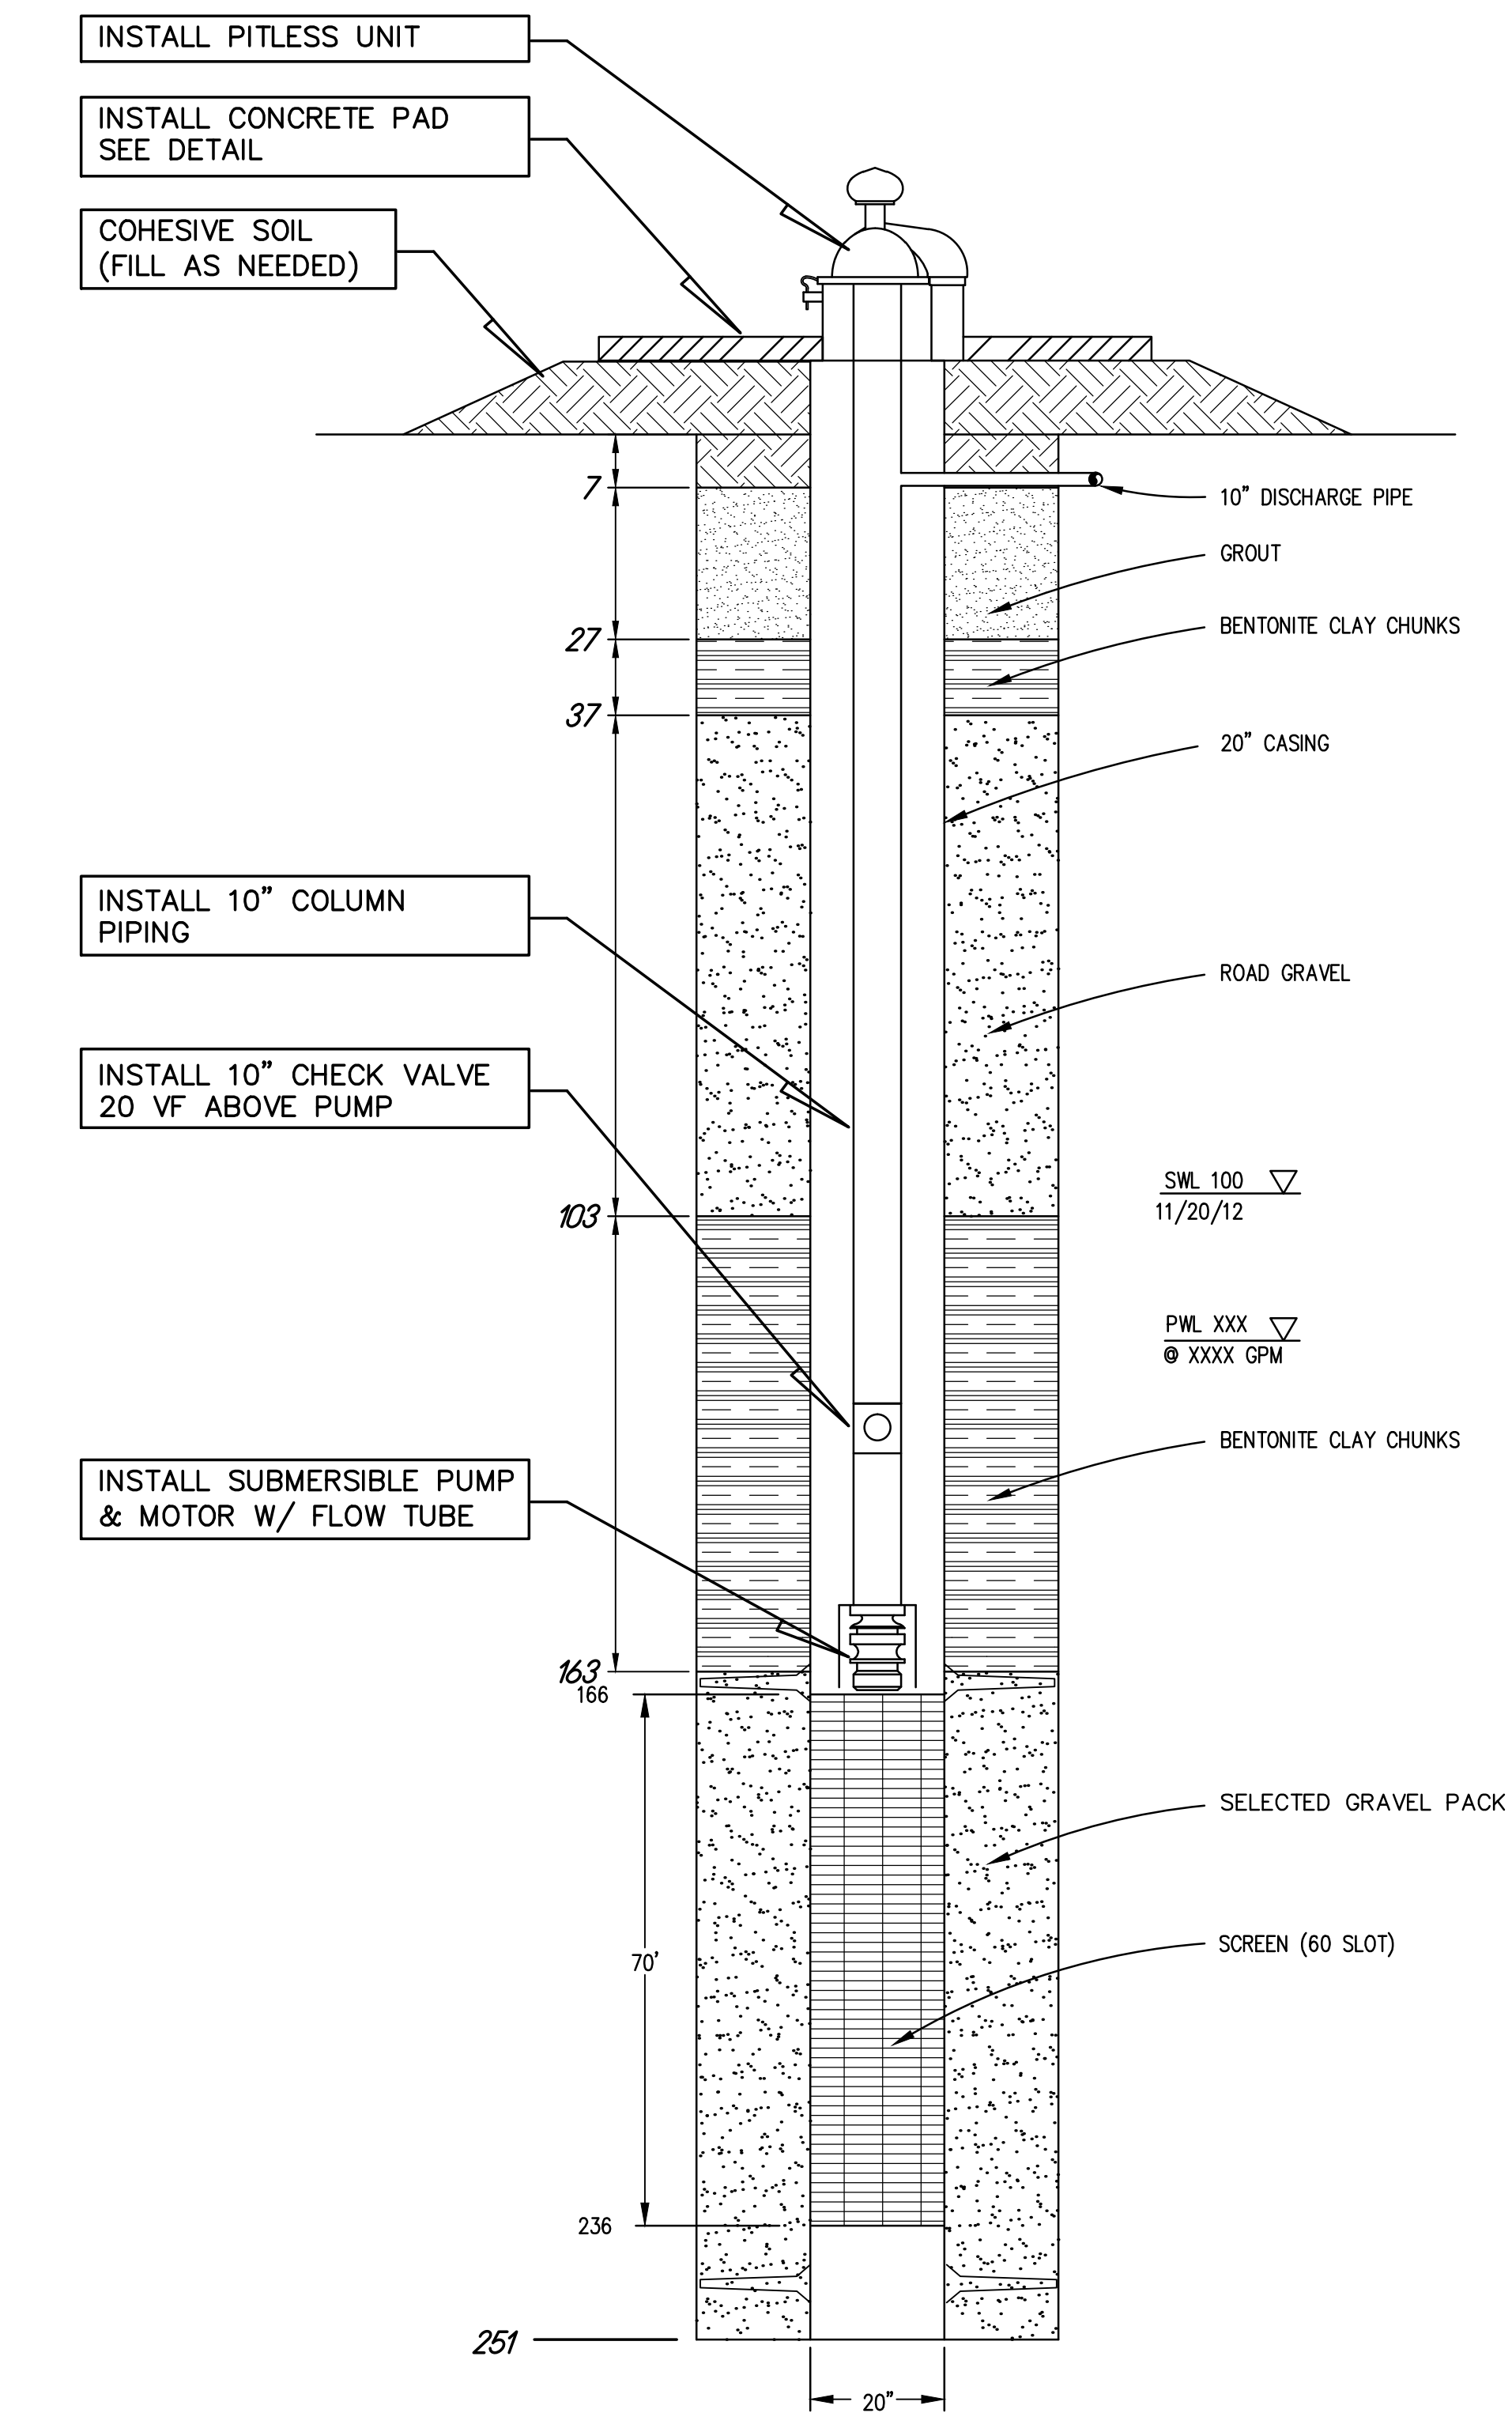

TEST PUMP DATA - WELL #9		
	START WATER LEVEL	END WATER LEVEL
AUG. WELL #9	89.963	101.775
AUG. WELL #8	71.861	71.718
OLD IRRIGATION WELL #9	71.954	73.203

SPECIFIC CAPACITY 118.5

FINAL HP	125
PUMP BOWLS	9TLC
TRIM	5.8125
STAGE	3

URNRD AUGMENTATION WELL #9 CONSTRUCTION

REVISIONS

BY

MA

Miller & Associates
Consulting Engineers, P.C.
Kearney, NE (308) 234-6456
McCook, NE (308) 345-3710

URNRD - AUGMENTATION - WATER SUPPLY WELLS & PIPING

URNRD AUGMENTATION WELL #9

DUNDY COUNTY, NEBRASKA

"AS RECORDED"

FROM INFORMATION PROVIDED BY THE CONTRACTOR.

DATE: 07-2013 BY: TLZ

THIS DOCUMENT WAS ORIGINALLY ISSUED AND SEALED BY CHRIS A. MILLER (E-8775), ON 12/10/2012.

THIS MEDIA SHOULD NOT BE CONSIDERED A CERTIFIED DOCUMENT.

VERIFY SCALES

BAR IS ONE INCH ON ORIGINAL DRAWING

0 1"

IF NOT ONE INCH ON THIS SHEET, ADJUST SCALES ACCORDINGLY.

SCALE: AS SHOWN

PROJECT NO. 159-P5-001

DATE: DECEMBER, 2012

FIELD BOOK M&A DWG NO. 25303

DRAWN BY: BSF

APRVD BY:

SHEET 17