



**SITE PLAN**  
**URNRD AUGMENTATION WELL #8**

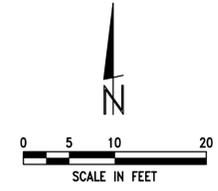

- NOTES:
1. ALL 10" WATER MAIN THROUGH METER PIT SHALL BE CLASS 350 DUCTILE.
  2. CONTRACTOR TO COORDINATE W/ SWPPD FOR POWER POLE LOCATION/REQUIRED DISCONNECT AND ALL UNDERGROUND FROM POWER POLE TO PANEL BOXES. POWER POLE TO BE MIN. 50' AWAY BUT NO GREATER THAN 75'.
  3. CONDUIT RUNS NOT SHOWN.
  4. CONTRACTOR VERIFY CONNECTION POINT BURY DEPTH PRIOR TO INSTALLING PITLESS UNIT.
  5. PIPING SHALL BE LAID TO ALLOW FOR AIR RELEASE TO EXISTING TRANSMISSION MAIN OR AIR RELEASE IN METER PIT.

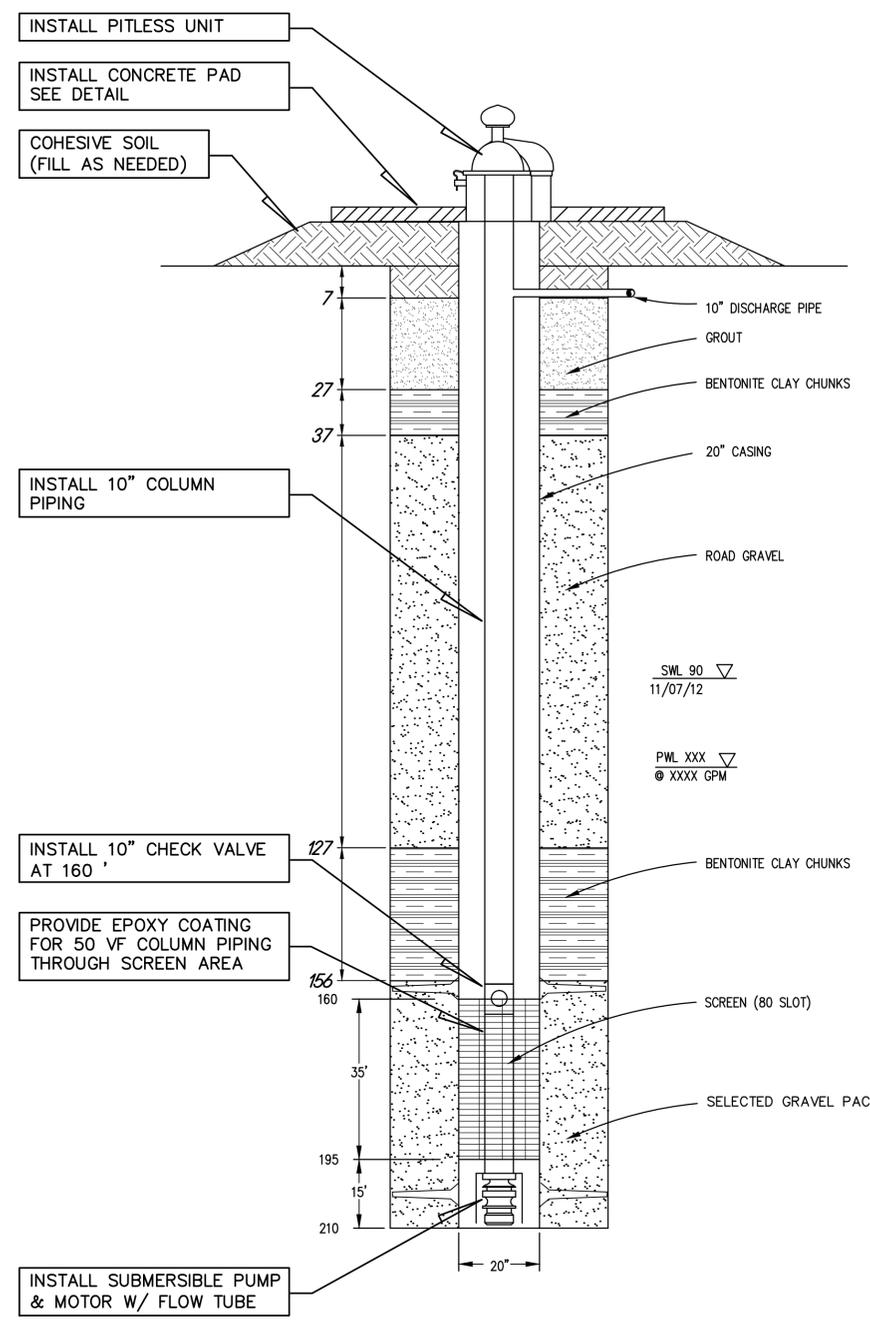

TEST PUMP DATA - WELL #8		
	START WATER LEVEL	END WATER LEVEL
AUG. WELL #8	71.95	117.837
AUG. WELL #9	89.957	90.219
AUG. WELL #7	70.722	70.645

SPECIFIC CAPACITY 30.5

FINAL HP	100
PUMP BOWLS	11CLC
TRIM	8.13
STAGE	1

**URNRD AUGMENTATION WELL #8**  
**CONSTRUCTION**

REVISIONS	BY

**M&A**  
Miller & Associates  
Consulting Engineers, P.C.  
Kearney, NE (308) 234-6486  
McCook, NE (308) 345-3710

**URNRD - AUGMENTATION - WATER SUPPLY WELLS & PIPING**  
**URNRD AUGMENTATION WELL #8**  
**DUNDY COUNTY, NEBRASKA**

"AS RECORDED"  
FROM INFORMATION PROVIDED BY THE CONTRACTOR.  
DATE: 07-2013 BY: TLZ  
THIS DOCUMENT WAS ORIGINALLY ISSUED AND SEALED BY CHRIS A. MILLER (E-8775), ON 12/10/2012. THIS MEDIA SHOULD NOT BE CONSIDERED A CERTIFIED DOCUMENT.

VERIFY SCALES  
BAR IS ONE INCH ON ORIGINAL DRAWING  
0 1"  
IF NOT ONE INCH ON THIS SHEET, ADJUST SCALES ACCORDINGLY.

SCALE: AS SHOWN  
PROJECT NO. 159-P5-001  
DATE: DECEMBER, 2012  
FIELD BOOK M&A DWG NO. 25305  
DRAWN BY: BSF APRVD BY: BSF  
SHEET 15

PLOTTED: 9/10/2013 10:59 AM  
 SAVED: 9/20/2013 2:14 PM Travis L. Zerr  
 C:\Projects\159\159-P5-001\Well Installations 10-2012\Civil-Dwg\As-Recorded\Well Site Plan.dwg